
PROJECT 2 DESIGN BUILD FIRM WITH APARTMENTS CHRIS CARPENTER AND BRANDON TAMMONE ARC 486 FALL 2022 PROFESSOR LOPICCOLO

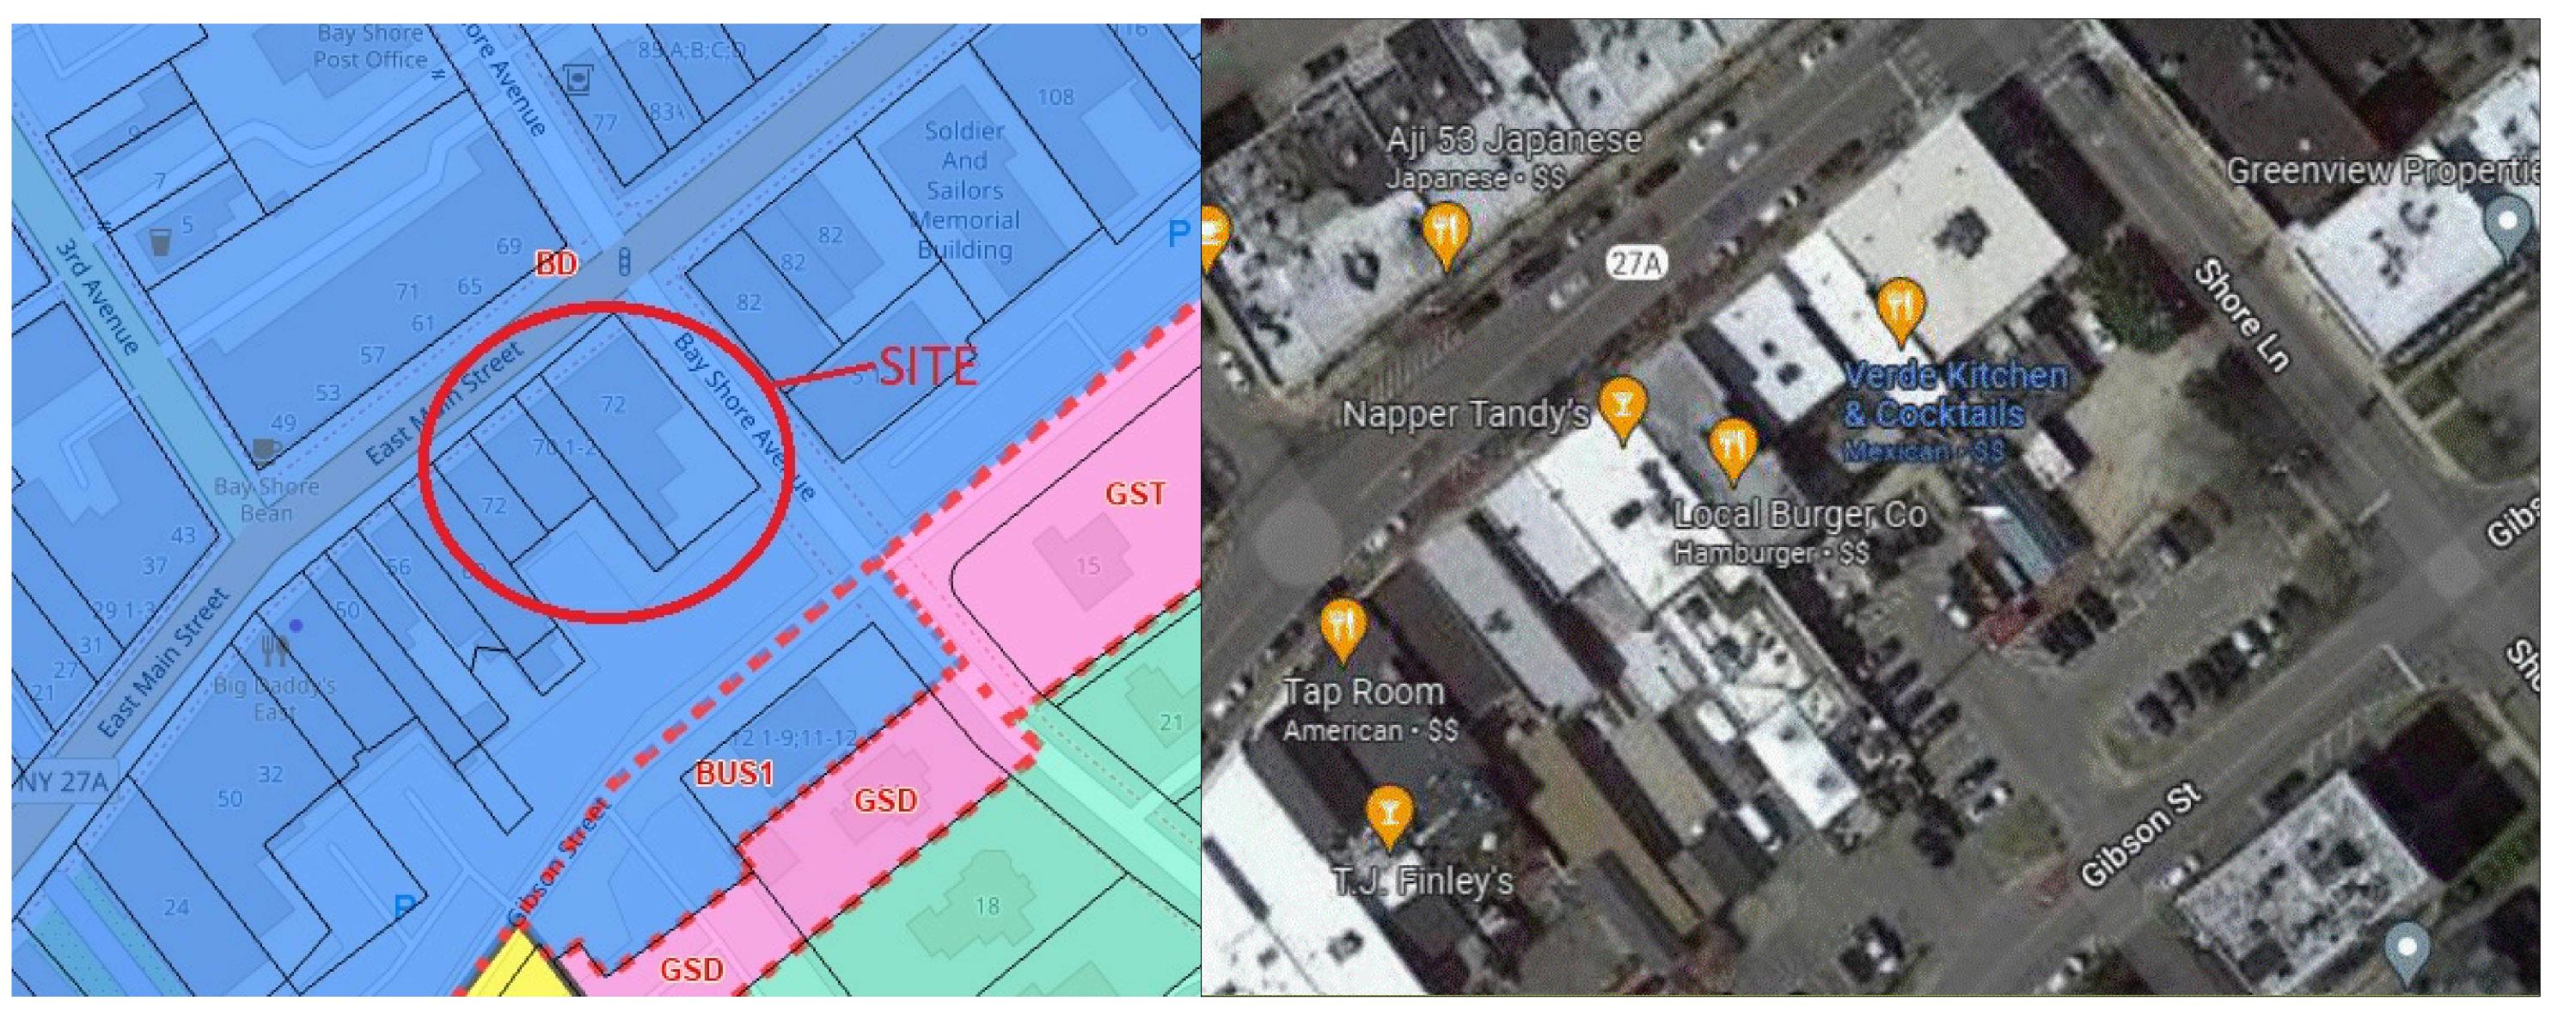

TAX INFO SITE AERIAL

SCALE: NTS

TABLE OF CONTENTS

A1 DEMOLITION PLAN

A2 SITE PLAN

A3 GRADING DRAINAGE AND SEPTIC

A4 FLOOR PLANS

A5 FLOOR PLANS

A6 ELEVATIONS

A7 SECTIONS

A8 3D VIEWS



THIS PROJECT THAT WE HAVE BEEN ASSIGNED TO DESIGN, IS A DESIGN BUILD FIRM AND APARTMENT COMPLEX ON A CORNER SITE ON THE STREETS OF SHORE LANE AND MAIN STREET, WHERE THERE IS MUCH FOOT TRAFFIC AND CAR TRAFFIC THERE ALL DAY LONG.



FARMINGDALE STATE COLLEGE


PROJECT
2
FINAL
PRESENTATION

Date: 12/13/22

SCALE: AS INDICATED

DRAWN BY:
CHRIS
CARPENTER
AND
BRANDON
TAMMONE

SHEET #
COVER

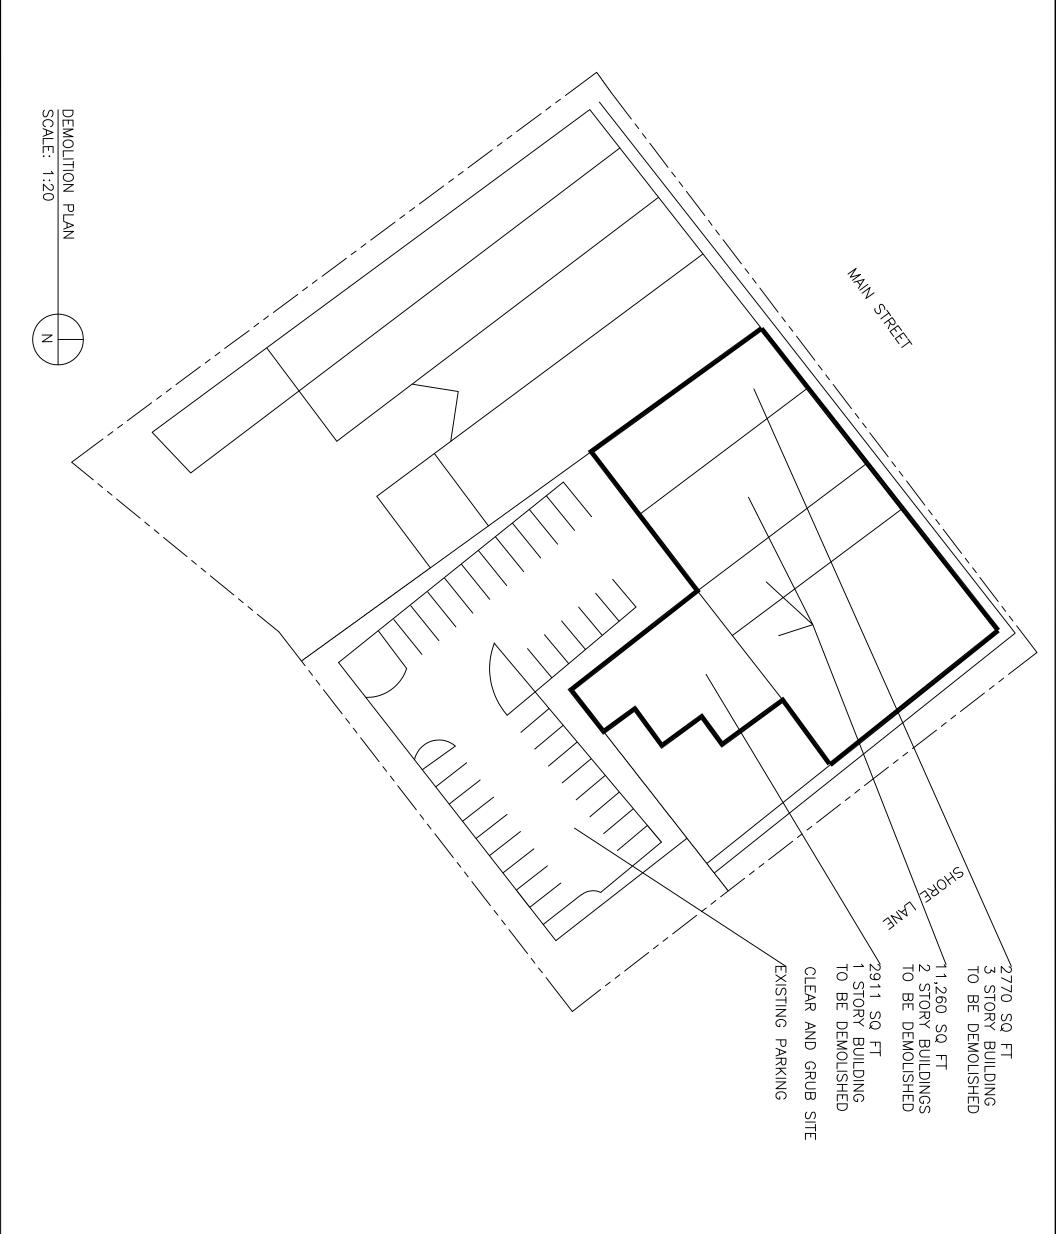



FARMINGDALE STATE COLLEGE

FINAL PRESENTATION PROJECT


Date: 12/13/22


SCALE:


INDICATED


AND BRANDON TAMMONE DRAWN BY: CHRIS CARPENTER

SHEET A1 ##

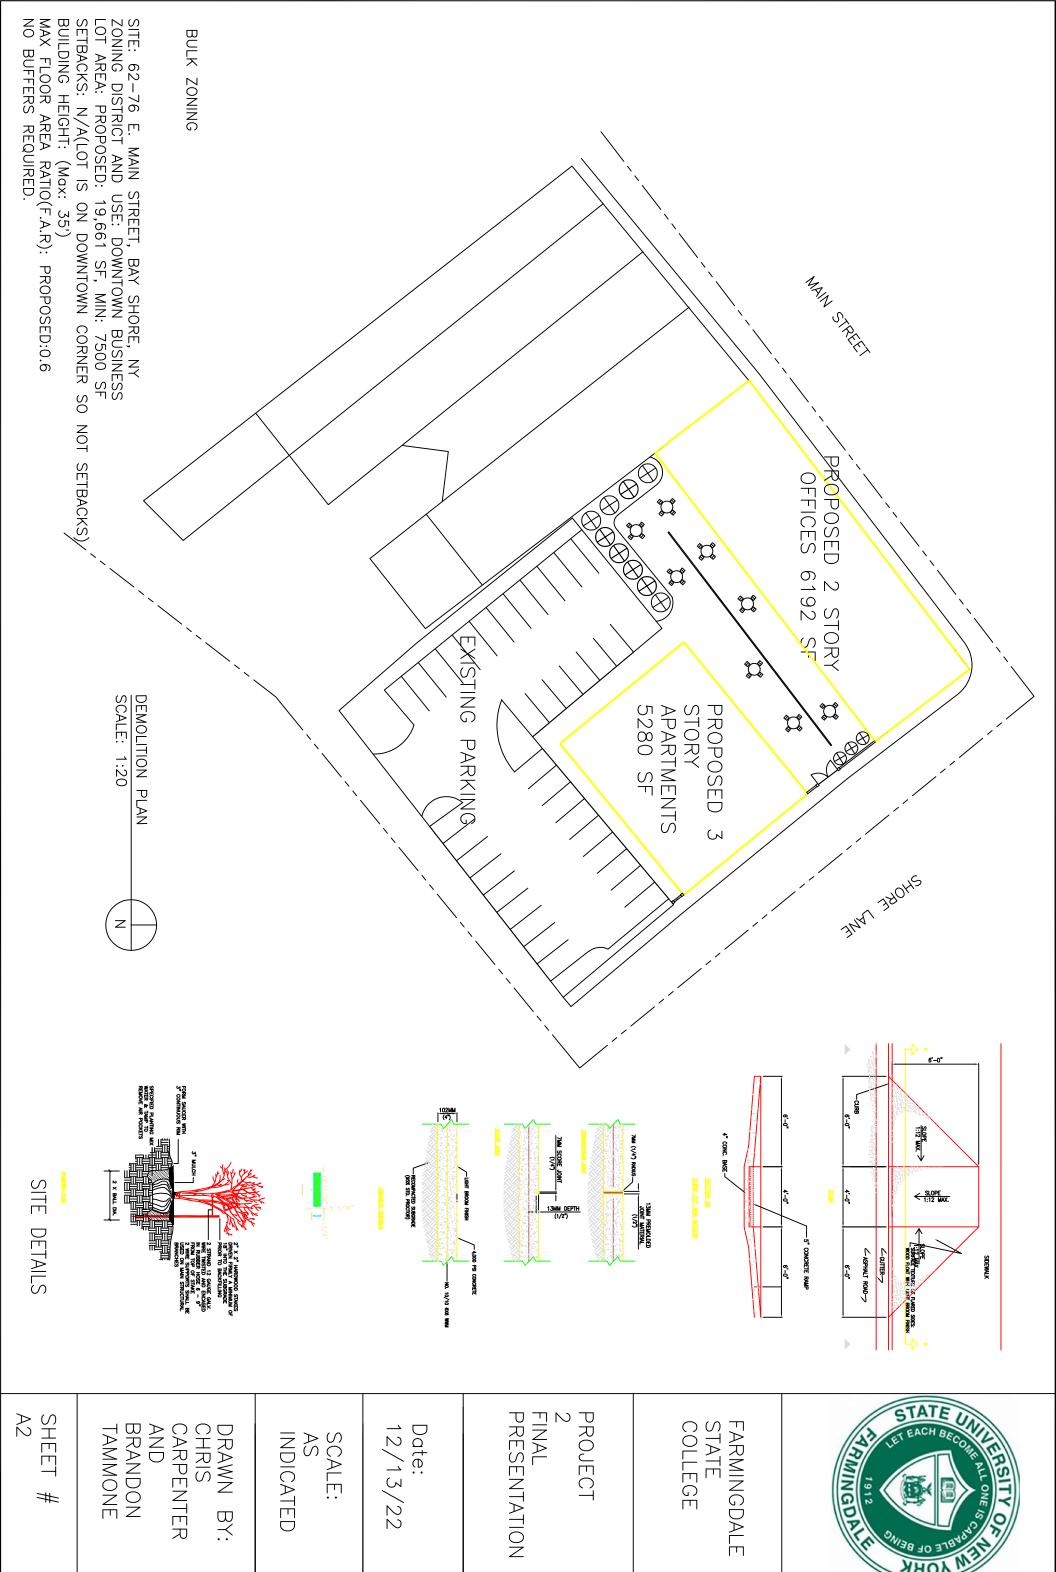

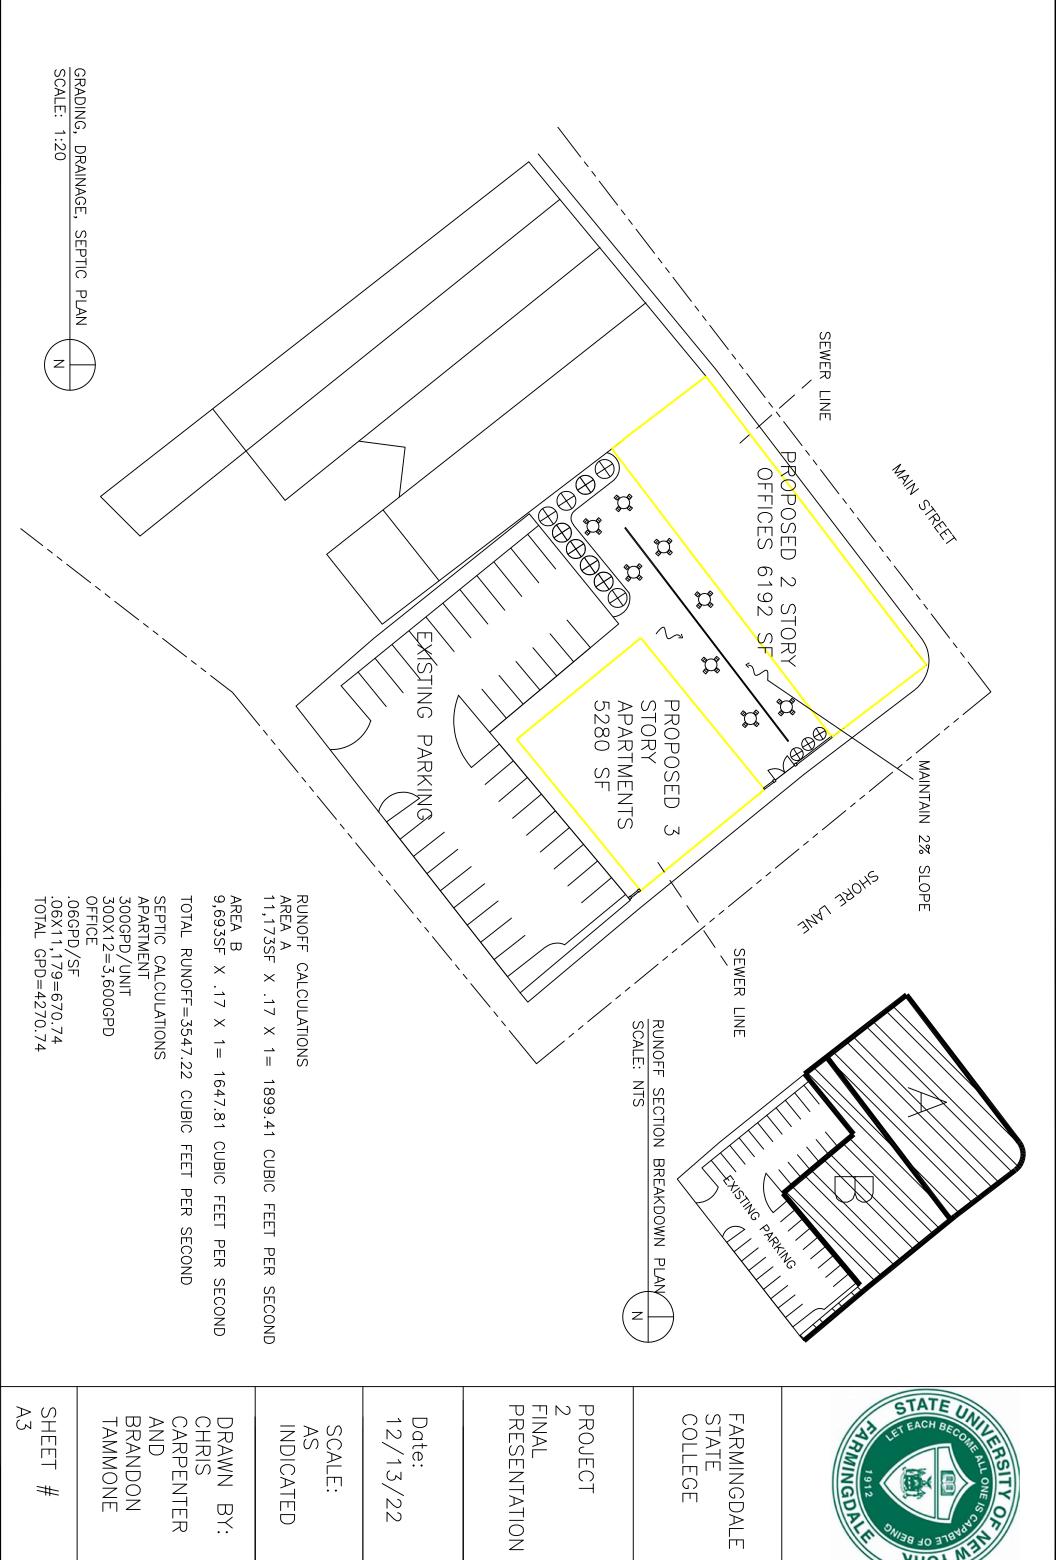

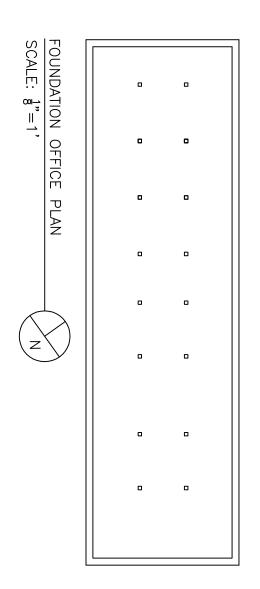

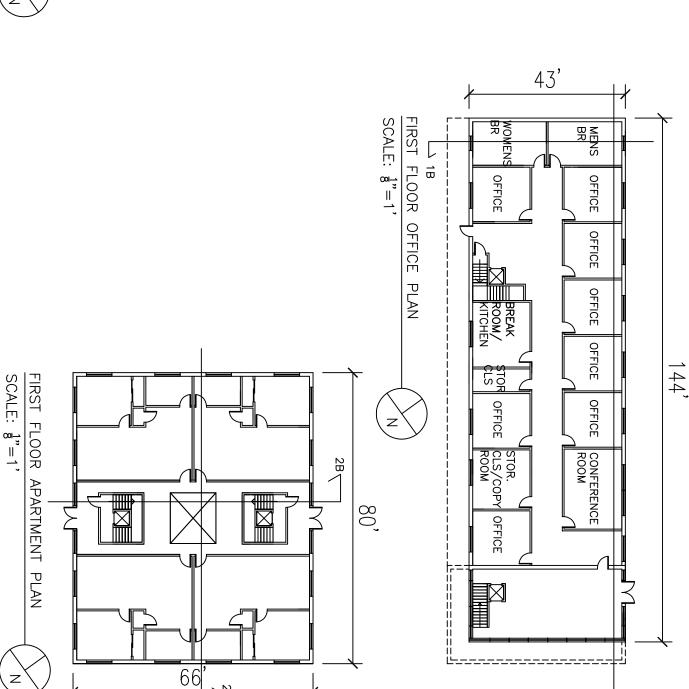

SQUARE FOOTAGES OFFICE OFFICE=237.75
CONFERENCE ROOM=348.7
BATHROOM=241.2
STORAGE CLOSET=126.8
BREAK ROOM=282.92

SCALE: $\frac{1}{8}$ "=1"

FOUNDATION APARTMENT PLAN

0

0

TOTAL SQUARE FOOTAGE OF BUILDING=11,179 SQ FT

TOTAL SQUARE FOOTAGE OF BUILDING=14,976

LIVING AREA=531.85 BATHROOM=102 CLOSET=40.5

SQUARE FOOTAGES APARTMENT BEDROOM=202.5



FARMINGDALE STATE COLLEGE


PROJECT
2
FINAL
PRESENTATION
Date:


Date: 12/13/22


SCALE: AS INDICATED

DRAWN BY:
CHRIS
CARPENTER
AND
BRANDON
TAMMONE


SHEET # A4

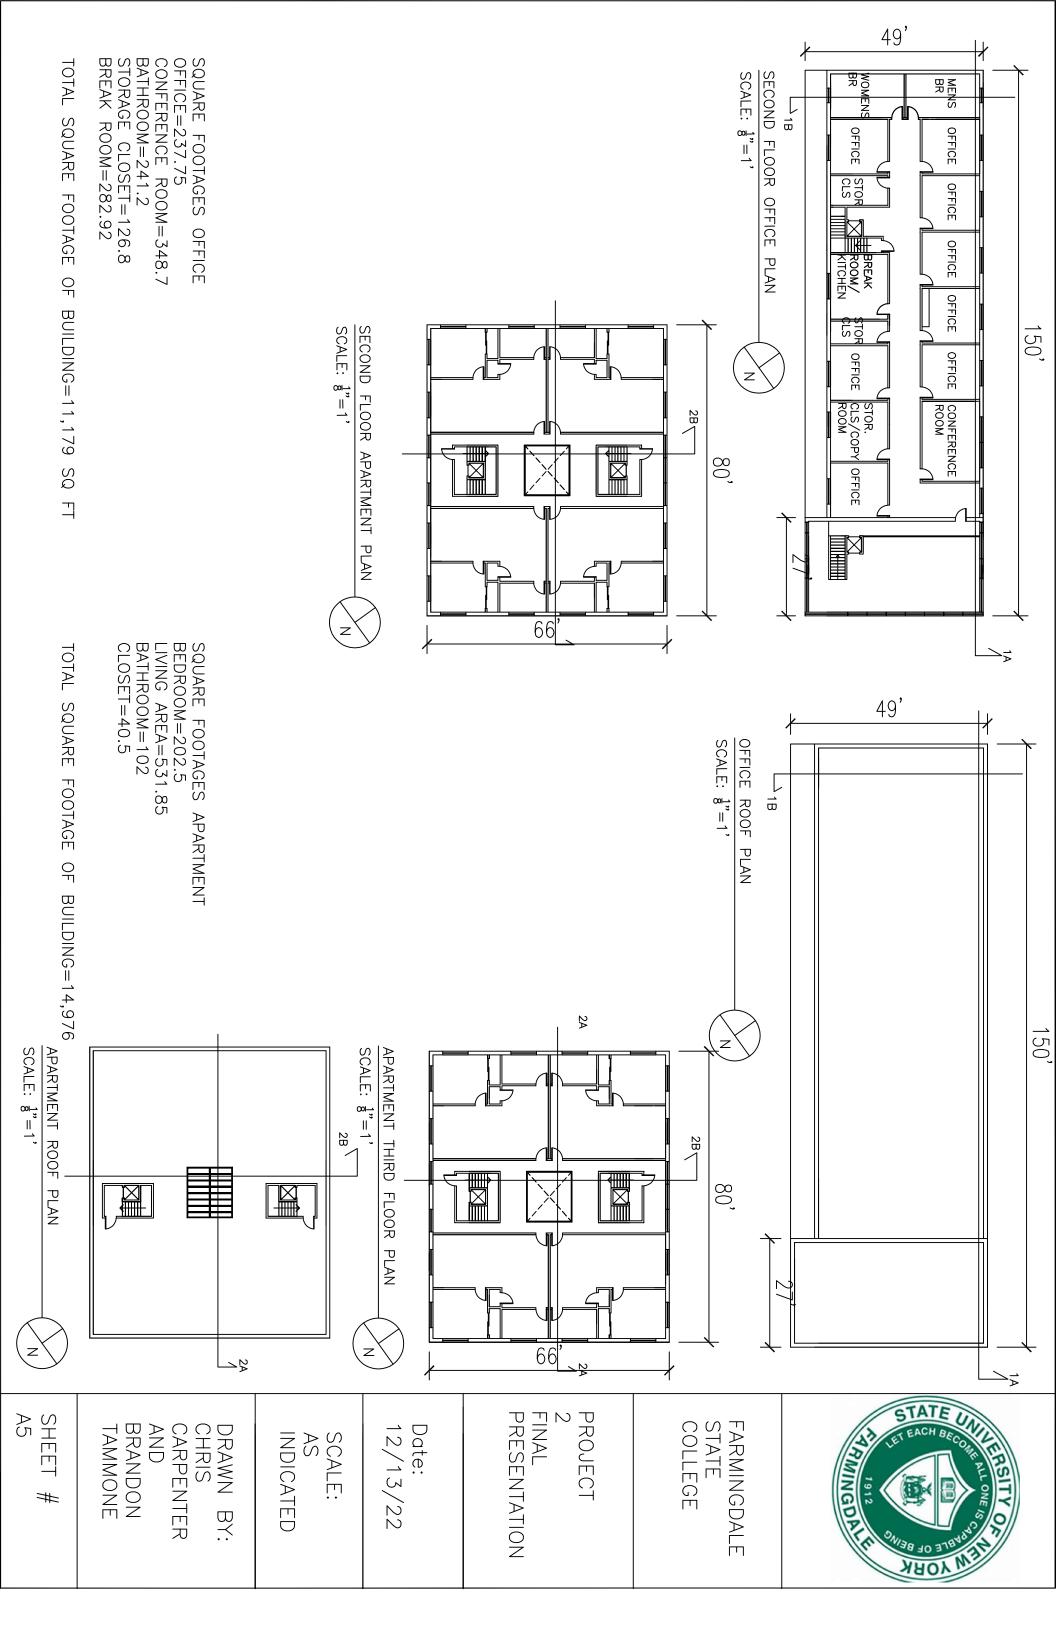

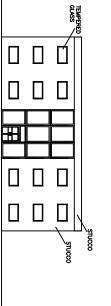


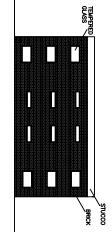



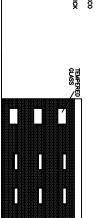

MINGOR

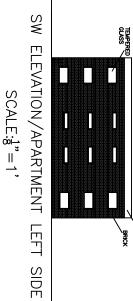




NE ELEVATION/APARTMENT RIGHT SIDE SCALE: $\frac{1}{8}$ "=1'

SE ELEVATION/APARTMENT REAR $SCALE: \frac{1}{8}"=1$

FARMINGDALE STATE COLLEGE

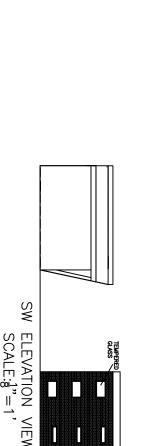


TEMPERED GLASS



FINAL PRESENTATION

PROJECT

NE ELEVATION VIEW SCALE: 3"=1"

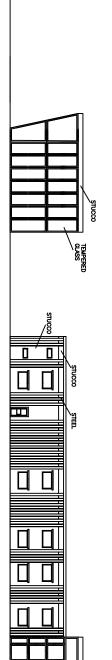



 $SCALE: \frac{1}{8}"=1$

NE ELEVATION/OFFICE RIGHT SIDE $SCALE: \frac{1}{8}"=1$

SE ELEVATION/OFFICE REAR

 $SCALE: \frac{1}{8}"=1$

SCALE: AS INDICATED

Date: 12/13/22

DRAWN BY: CHRIS CARPENTER BRANDON TAMMONE

SHEET A6 #

SHEET A7


#

CONSTRUCTION DETAILS

STEEL TO ROOF DETAIL B

STEEL TO FOUNDATION DETAIL

STRUCTURAL GLASS

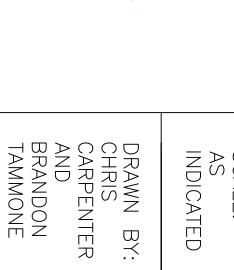

SUBFLOOR
STEEL BEAM
AIR/WATER BARRIER
2' CONTINUOUS INSULATION
WITH DRAINAGE CHANNELS

AIR/VATER BARRIER
GYPSUM SHEATHING
2° CONTINUOUS INSULATI
VITH DRAIMAGE
CHANNELS

AIR/WATER BARRIER— SELF-FURRING METAL— LATH

FLEXIBLE FLASHING

GYPSUM PANELS -STEEL BEAM -CAVITY INSULATION-

2" CONTINUOUS INSULATION
VITH DRAINAGE CHANNELS
PORTLAND CEMENT PLASTER
2-7/8" VEEP SCREED

2-7/8" CASING BEA

SELF-FURRING

SECTION 2A SCALE:1/4"=1'

SECTION 2B

10'

⊫

SCALE: 1/4"=1'

BUILDING PAPER——
PORTLAND CEMENT——
PLASTER
GYPSUM PANELS——
FLOOR SYSTEM———

STEEL TO FLOOR DETAIL

SELF-FURRING LATH-

SCALE: AS INDICATED


Date: 12/13/22


FINAL PRESENTATION

PROJECT

10' 32'

10'

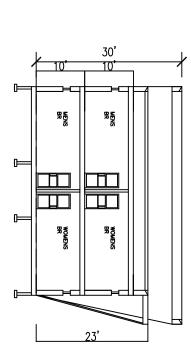

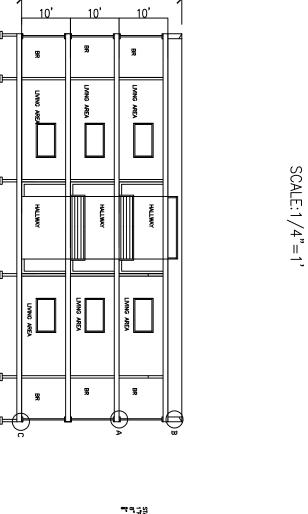

32'

10'

SCALE:1/4"=1" SECTION 1B

FARMINGDALE STATE COLLEGE

BR MENS RANG | 30

SECTION 1A



SHEET A8 #

DRAWN BY: CHRIS CARPENTER AND BRANDON TAMMONE

3D VIEW SCALE: 1"=1"

PROJECT 2 FINAL PRESENTATION FARMINGDALE STATE COLLEGE ARMINGOR


Date: 12/13/22 SCALE: AS INDICATED

SHEET A9 #

DRAWN BY: CHRIS CARPENTER AND BRANDON TAMMONE

3D VIEW SCALE: 1"=1"

ARMINGOR

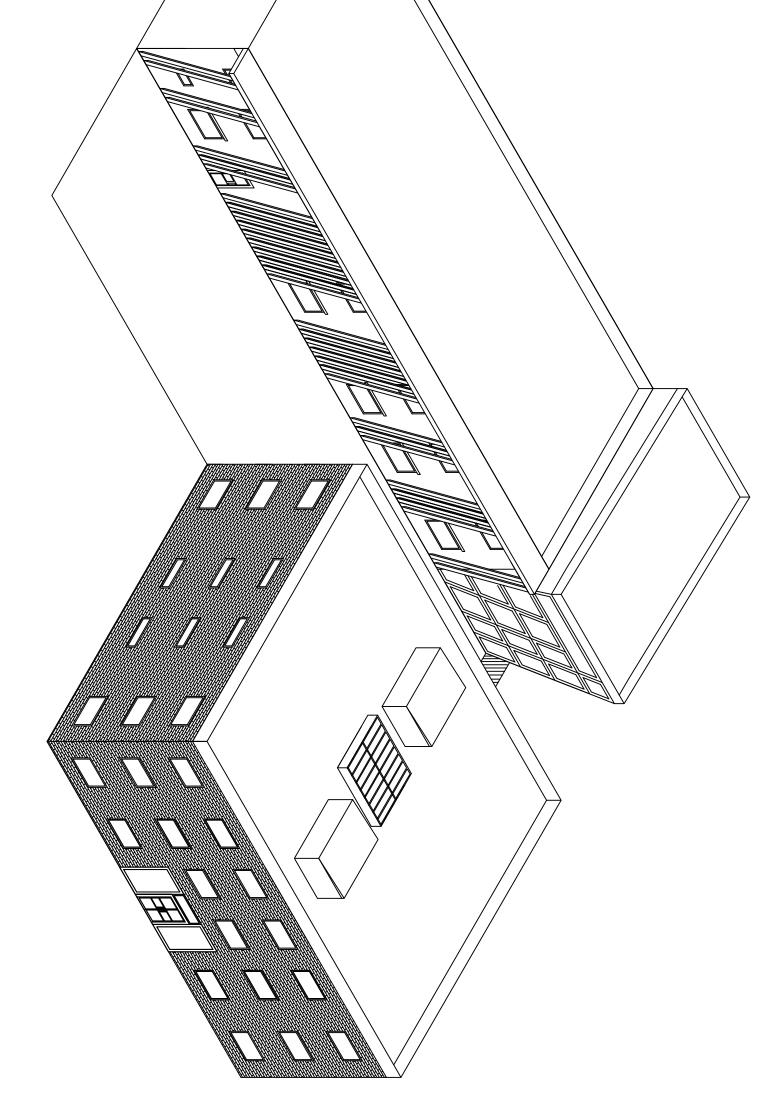

FARMINGDALE STATE COLLEGE

PROJECT
2
FINAL
PRESENTATION

Date: 12/13/22

SCALE: AS INDICATED